

JON M. HUNTSMAN, JR. Governor

GARY R. HERBERT Lieutenant Governor

### Department of Administrative Services

KIMBERLY HOOD Executive Director

Director

Division of Facilities Construction and Management F. KEITH STEPAN

### **ADDENDUM**

Date: 02-15-2007

To: Contractors

From: **Jeff Reddoor Project Manager** 

Southern Utah University Digital Photo Lab Remodel

DFCM Project No. **06126730** 

Subject: Addendum No.1

Pages: Addendum Cover Page 1 Page
Architects Clarifications and Drawing 8 Pages
Total 9 Pages

Note: This Addendum shall be included as part of the Contract Documents. Items in this Addendum apply to all drawings and specification sections whether referenced or not involving the portion of the work added, deleted, modified, or otherwise addressed in the Addendum. Acknowledge receipt of this Addendum in the space provided on the Bid Form. Failure to do so may subject the Bidder to disqualification.

### SCHEDULE HAS NOT BEEN CHANGED

1.1 Architect added Drawing and Clarifications.

End of Addendum





### addendum 1

DATE: February 15, 2007

DFCM Project No.: 06126730

Archiplex Group Project No.: 0620.01

# ADDENDUM NO. 1 to the Contract Documents for the Construction of the Digital Photo Lab Remodel – SUU, Cedar City, Utah

The contents of this addendum supersede the information contained in the original Contract Documents and are hereby incorporated therein. Unless otherwise so stated, any changes herein offset only the specific drawings, words, or paragraphs mentioned, and the balance of the drawings and specifications remain in full force.

#### A. ADDENDUM ITEMS:

#### 1. Architectural Addendum Items:

#### Sheet AD101:

- a. Carpet to be removed in existing offices: 109, 110, & 111.
- b. Added Keynote regarding removing another existing meter and capping lines..

#### Sheet AE100:

a. Added exiting plan for information only per DFCM code official.

#### Sheet AE101:

a. Selected window and door #'s have changed to 200 series.

#### Sheet AE121:

b. Direction of new exit signs have been changed.

#### Sheet AE601:

- a. Label numbers have been adjusted on the window details and window schedule. Labels in door schedule has been switched so that the detail number comes before the drawing number.
- b. Hardware lockset has been added to door schedule for door #D203-A.




- c. Description 1 in wall descriptions has been changed to read: Paint to match quality and appearance of adjoining smooth walls to create seamless appearance.
- d. Remark added to schedule for door #D202-A concerning reinforcement of new door header.

#### 2. Electrical Addendum items:

#### **Sheet EP102**

a. Provide a Horn/ Strobe on wall in reception area.

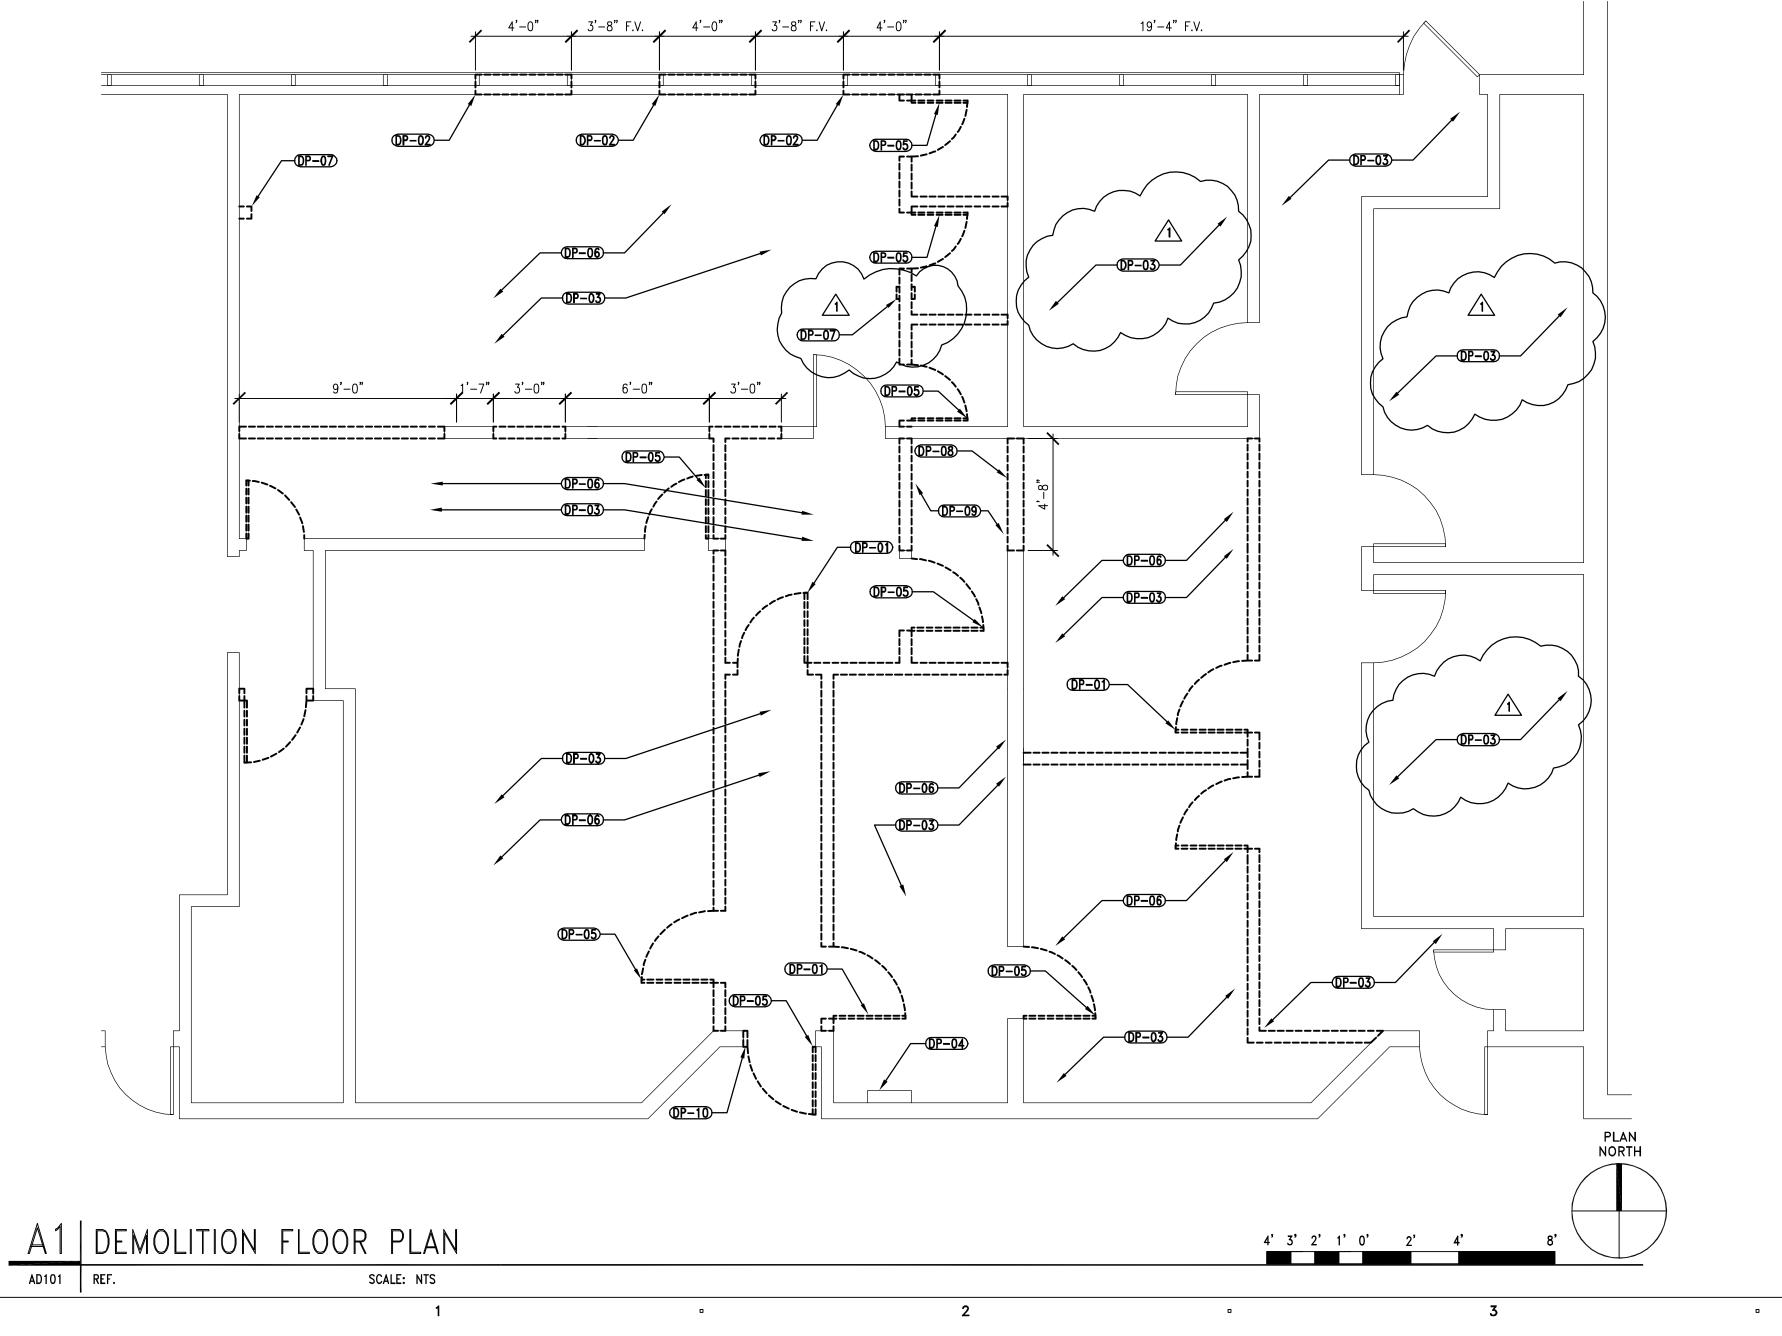

## GENERAL NOTES

1. FIELD VERIFY ALL EXISTING CONDITIONS AND THEIR COMPATIBILITY WITH NEW CONSTRUCTION PRIOR TO THE COMMENCEMENT OF WORK. COORDINATE DISCREPANCIES WITH ARCHITECT.

2. DO NOT SCALE DRAWINGS.

3. SEE MECHANICAL AND ELECTRICAL DRAWINGS FOR MORE INFORMATION.

4. DASHED LINES REPRESENT WALLS AND DOORS TO BE REMOVED.

5. ALL DIMENSIONS ARE TO FACE OF WALL, UNLESS NOTED OTHERWISE.

6. CONTRACTOR SHALL PROTECT ALL EXISTING FINISHES FROM DAMAGE DURING DEMOLITION AND REPAIR OR REPLACE ANY MATERIAL THAT IS DAMAGED.

7. CONTRACTOR SHALL VERIFY LOCATION OF ALL DUCTWORK, WATERLINES, GAS LINES, & OTHER UTILITIES SERVING THE EXISTING BUILDING & KEEP THEM IN WORKING ORDER.

8. COVER RETURN AIR OPENINGS BEFORE AND DURING CONSTRUCTION.

9. PREPARE ALL WALLS AFFECTED BY DEMOLITION TO RECIEVE NEW FINISHES.

# DEMOLITION FLOOR PLAN KEYNOTES

(DP-01)	SAVE AND REUSE DOOR & FRAME (SEE DOOR SCHEDULE FOR PLACEMENT)
(DP-02)	ALTERNATE #1: DEMOLISH C.M.U. WALL AS REQ'D TO ACCOMODATE NEW WINDOW. CORD. OPENING SIZE W/ STOREFRONT MULLION SPACING. RE: AE601
<u> </u>	REMOVE AND SALVAGE EXISTING CARPET, PREP FLOOR AS REQUIRED TO RECEIVE NEW FINISH.
(DP-04)	EXISTING ELECTRICAL PANEL TO REMAIN
<u> </u>	REMOVE AND DISCARD INTERIOR DOORS, HARDWARE, AND FRAMES  - WILL BE PICKED UP BY SUU LOCKSHOP
(DP-06)	REMOVE AND DISCARD EXISTING CEILING ABOVE, DISCARD ALL LIGHTING
(DP-07)	REMOVE METER & CAP LINES
(DP-08)	C.M.U. WALL
(DP-09)	PREPARE CEILING AND WALL AS NEEDED TO TERMINATE NEW

COMMUNICATION CONDUITS IN THIS AREA.

**OP-10** SAWCUT BLOCK TO ENLARGE OPENING FOR NEW 3'-0" DOOR

CLIENT

SOUTHERN
UTAH
UNIVERSITY
DIGITAL PHOTO LAB
UNIVERSITY BUILDING # 132
STATE BUILDING # 4895
109 SOUTH 800 WEST

DESIGNER



CEDAR CITY, UTAH 84720

architecture · planning · design services

1135 South West Temple, Ste. A
Salt Lake City, UT 84101
P:(801) 961-7070
F:(801) 961-7373

CONSULTANTS

PROFESSIONAL SEAL



$\triangle$	02-15-07	ADDENDUM #	<b>¥</b> 1
MARK	DATE	DESCRIPTION	
DFCM CONTRACT NO: 07700			077004
DFCM PROJECT NO:			06126730
ARCHIPLEX PROJECT NO:			0620.01

DI OM CONTINACT NOT	0//00-
DFCM PROJECT NO:	06126730
ARCHIPLEX PROJECT NO:	0620.01
DRAWN BY:	E. RUSTEN
CHECKED BY:	R. STANISLAW
SCALE:	1/4"=1'-0"
DATE:	OCTOBER 27, 2006
KEY PLAN	

SHEET TITLE

DEMOLITION PLAN


AD101

CLIENT GENERAL NOTES 1. HATCHED AREA INDICATES EXTENT OF REMODEL DIGITAL PHOTO LAB
UNIVERSITY BUILDING # 132
STATE BUILDING # 4895
109 SOUTH 800 WEST
CEDAR CITY, UTAH 84720 DESIGNER P:(801) 961-7070 F:(801) 961-7373 7/17-82 TY 8-12 \$/1Z-1E 8/1Z-1E - t/s11-18 ...... CONSULTANTS ---- HOOD ABY. PROFESSIONAL SEAL CHECKED BY: OCTOBER 27, 2006 KEY PLAN SHEET TITLE EXITING PLAN AE100 REF. SCALE: 1/8" = 1'-0"

SOUTHERN UTAH




architecture · planning · design services 1135 South West Temple, Ste. A Salt Lake City, UT 84101

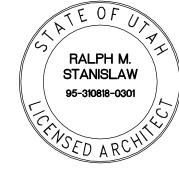

MARK	DATE	DESCRIPTION		
DFCM CONTRACT NO:				077004
DFCM PROJECT NO:			06	126730
ARCHIPLEX PROJECT NO:			(	0620.01
DRAWN BY:			F	RUSTEN

R. STANISLAW AS SHOWN

AE100

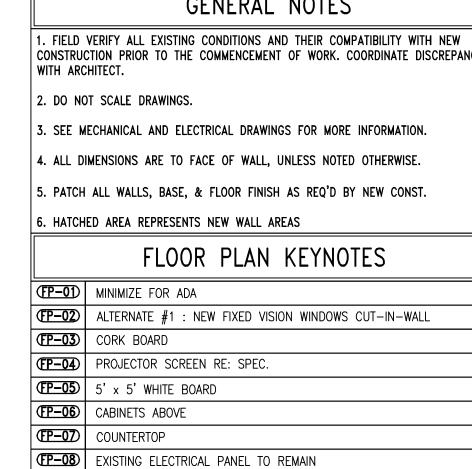

(FP-09) NEW WALL OR INFILL WALL (PAINTED GYPSUM)

18" LOCKABLE LOWER CABINETS

COMPUTER DESKS SHELVING ABOVE

# GENERAL NOTES

CONSTRUCTION PRIOR TO THE COMMENCEMENT OF WORK. COORDINATE DISCREPANCIES

3. SEE MECHANICAL AND ELECTRICAL DRAWINGS FOR MORE INFORMATION.

4. ALL DIMENSIONS ARE TO FACE OF WALL, UNLESS NOTED OTHERWISE.

	FLOOR PLAN KEYNOTES	DESIGNER	<b>≀</b> —
)	MINIMIZE FOR ADA		
)	ALTERNATE #1 : NEW FIXED VISION WINDOWS CUT-IN-WALL		
)	CORK BOARD		
)	PROJECTOR SCREEN RE: SPEC.		
)	5' x 5' WHITE BOARD		200
)	CABINETS ABOVE		
)	COUNTERTOP		

CONSULTANTS

CLIENT

SOUTHERN

UTAH

DIGITAL PHOTO LAB UNIVERSITY BUILDING # 132


STATE BUILDING # 4895 109 SOUTH 800 WEST

CEDAR CITY, UTAH 84720

architecture · planning · design services

1135 South West Temple, Ste. A Salt Lake City, UT 84101 P:(801) 961-7070 F:(801) 961-7373

PROFESSIONAL SEAL

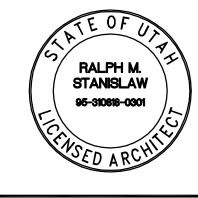


ISSU	ISSUE			
1	02/15/07	ADDENDUM #1		
MAR	C DATE	DESCRIPTION		
DFCN	CONTRACT	NO:	077004	


DI 0111 0011111/101 1101	0,,00,
DFCM PROJECT NO:	06126730
ARCHIPLEX PROJECT NO:	0620.01
DRAWN BY:	E. RUSTEN
CHECKED BY:	R. STANISLAW
SCALE:	AS SHOWN
DATE:	OCTOBER 27, 2006
KEY PLAN	

SHEET TITLE

FLOOR PLAN AND WALL **TYPES** 

AE101

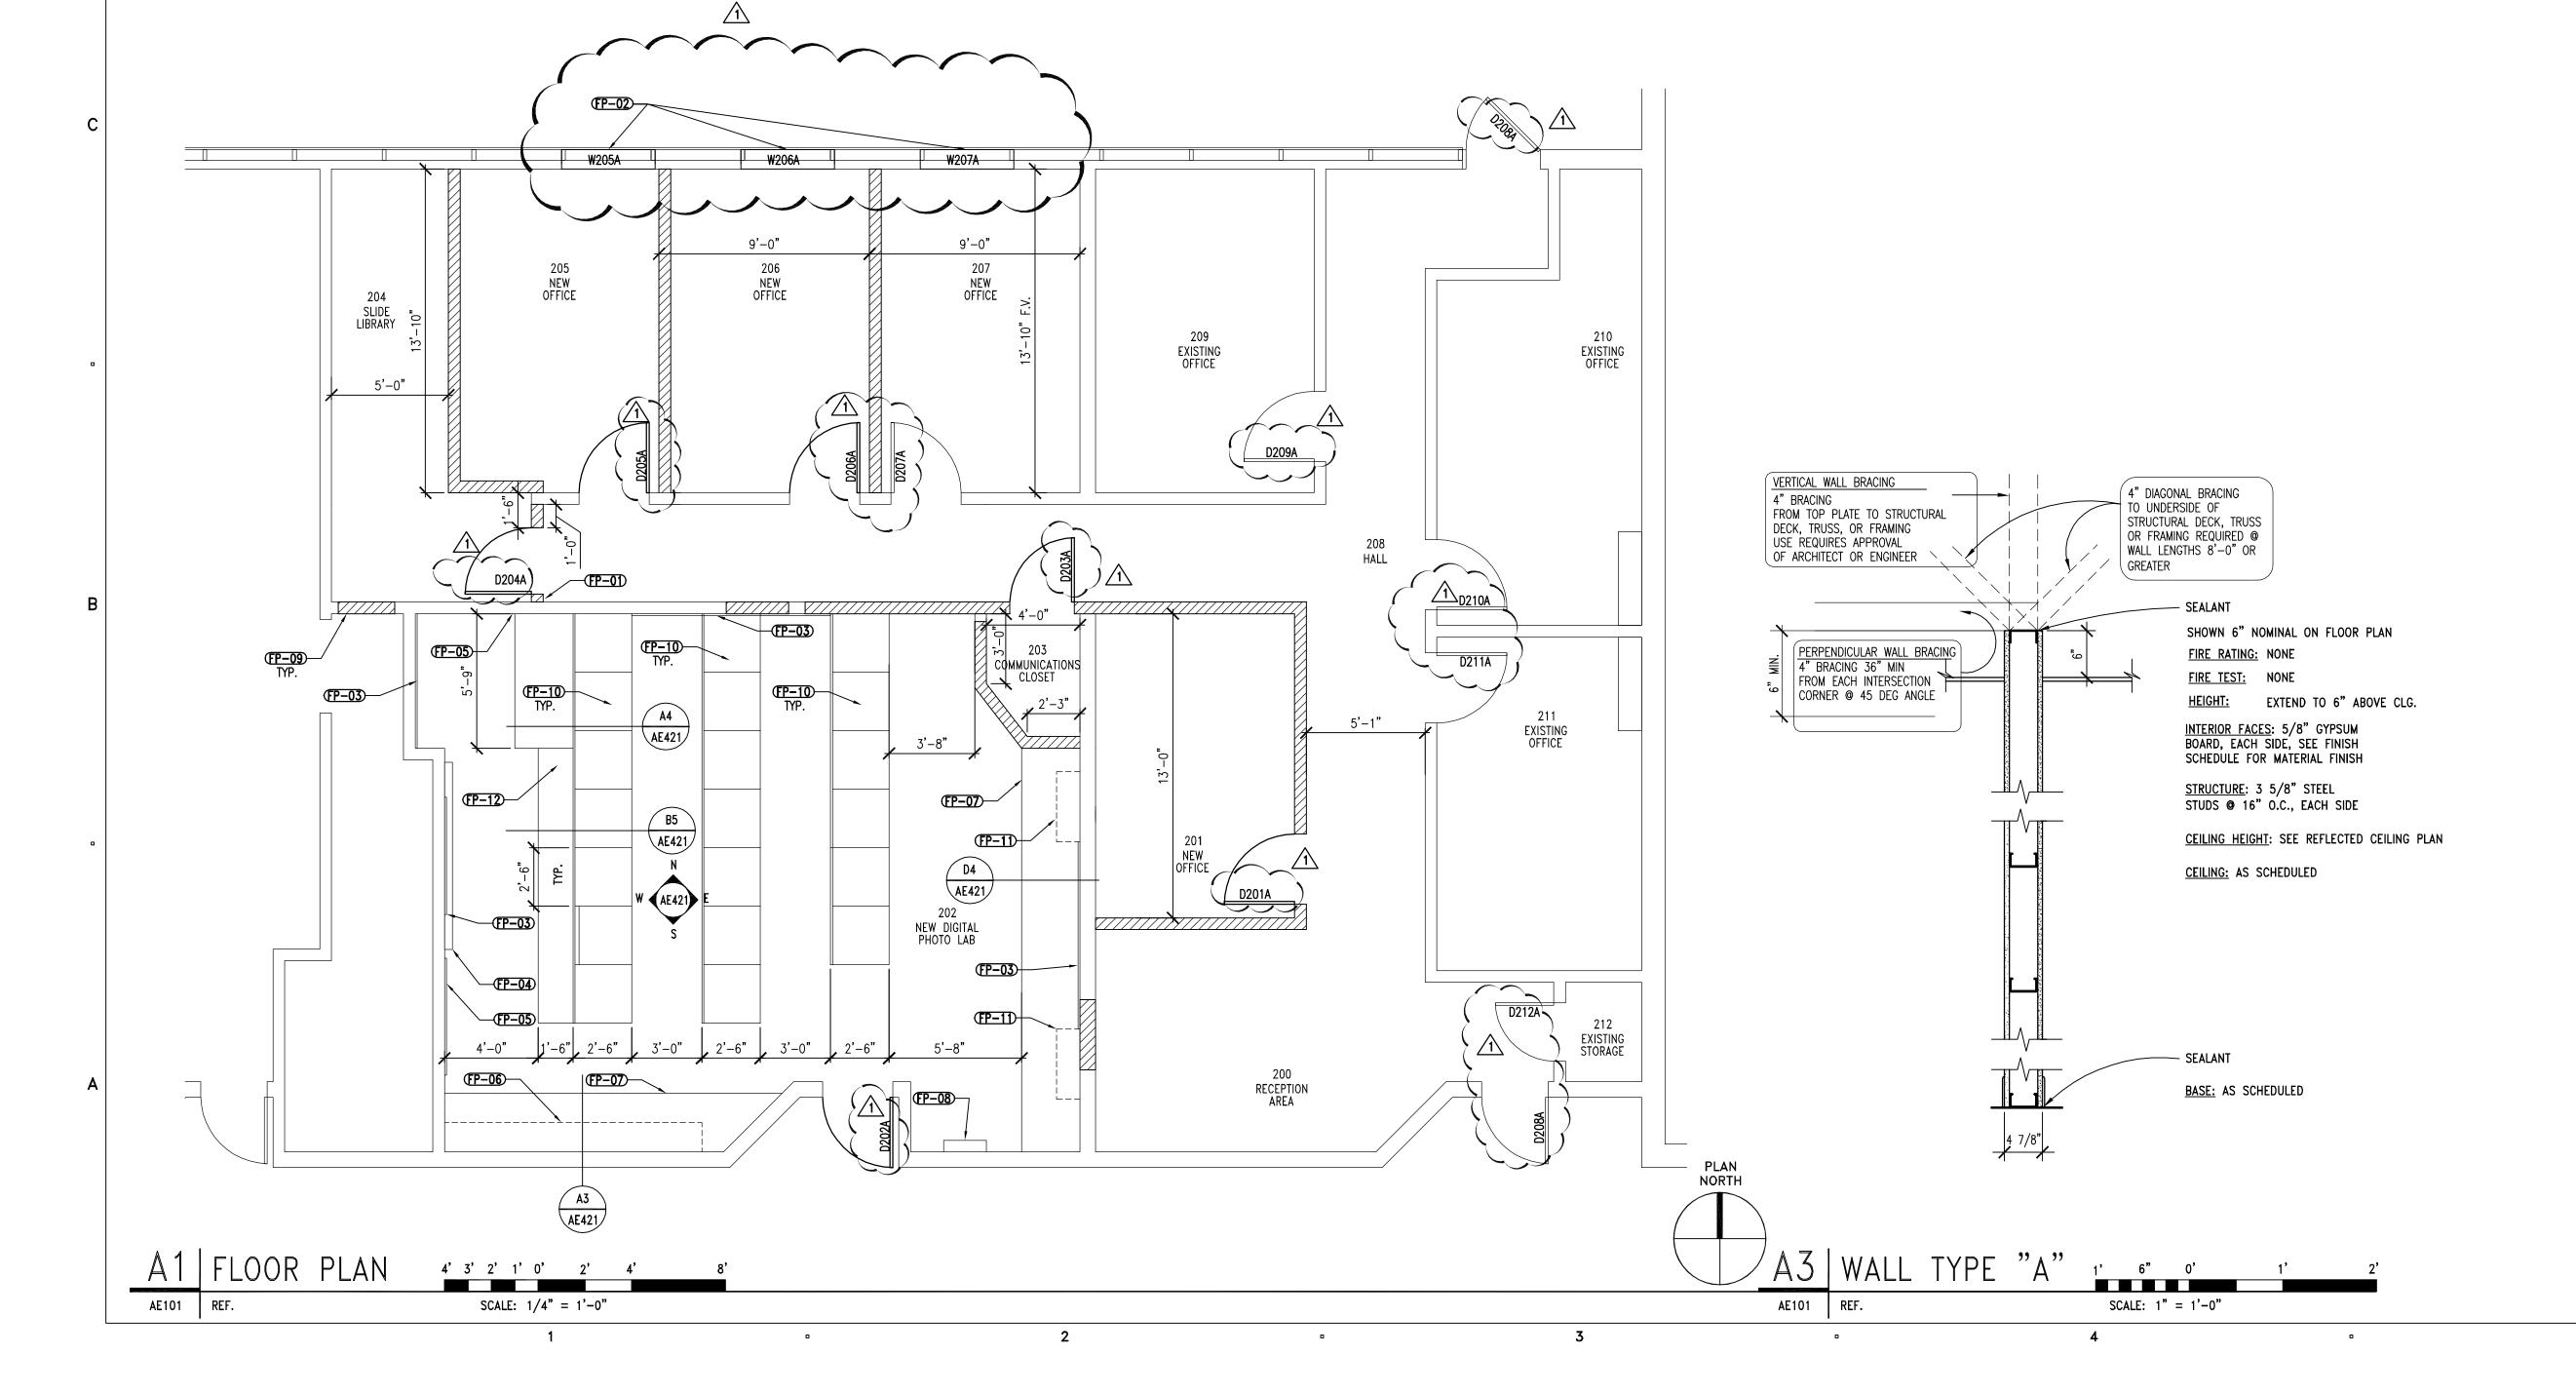

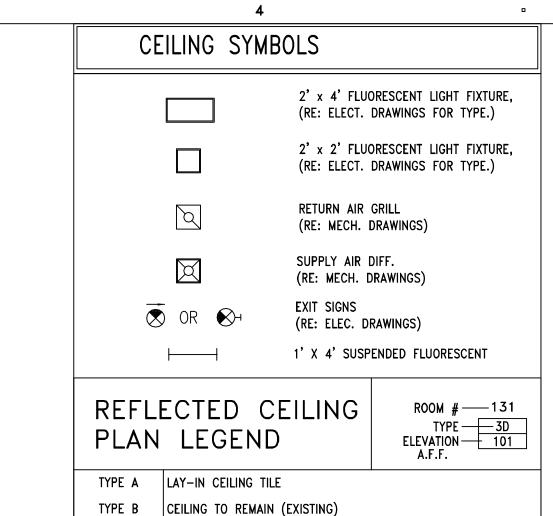

TYPE C EXPOSED STRUCTURE

A4 SEISMIC BRACING DETAILS

SCALE: NTS

AE121 REF.

1. FIELD VERIFY ALL EXISTING CONDITIONS AND THEIR COMPATIBILITY WITH NEW CONSTRUCTION PRIOR TO THE COMMENCEMENT OF WORK. COORDINATE DISCREPANCIES WITH ARCHITECT.			
2. DO NOT SCALE DRAWINGS.			
3. SEE MECHANICAL AND ELECTRICAL DRAWINGS FOR MORE INFORMATION.			
4. CEILING HEIGHT SHOWN IN ROOM TAG INDICATES HEIGHT OF DOMINANT CEILING FINISH. SEE NOTES FOR ADDITIONAL CEILING FINISH INFORMATION.			
5. HATCHED AREA INDICATES EXISTING CEILING TO REMAIN.			
REFLECTED CEILING PLAN KEYNOTES			
JOIN EXISTING TO NEW LAY-IN CE	EILING SYSTEM NEAR DASHED LINE		
P-02 NEW LAY-IN CEILING			

CP-06 CEILING MOUNTED PROJECTOR RE: 421/B4

(CP-07) CEILING MOUNTED PROJECTOR SCREEN

GENERAL NOTES

5. HATC	HED AREA INDICATES EXISTING CEILING TO REMAIN.		CEDAR CITY, UTAH 84720
F	REFLECTED CEILING PLAN KEYNOTES		DESIGNER
(CP-01)	JOIN EXISTING TO NEW LAY-IN CEILING SYSTEM NEAR DASHED LINE		ARCHIPLEX
(CP-02)	NEW LAY-IN CEILING		
<u>CP-03</u>	B.O. NEW HEADER @ 8'-6"		G R O U P
<b>CP-04</b>	LIGHT FIXTURES TO REMAIN, CONTRACTOR TO CLEAN FIXTURES AND LENSES		architecture · planning · design services
<u>CP-05</u>	EXISTING LAY-IN CEILING	-	1135 South West Temple, Ste. A Salt Lake City, UT 84101
(P-06)	CEILING MOUNTED PROJECTOR RE: 421/R4		P:(801) 961-7070

CONSULTANTS

PROFESSIONAL SEAL

CLIENT

SOUTHERN

UTAH


UNIVERSITY

DIGITAL PHOTO LAB UNIVERSITY BUILDING # 132

STATE BUILDING # 4895

109 SOUTH 800" WEST

F:(801) 961-7373

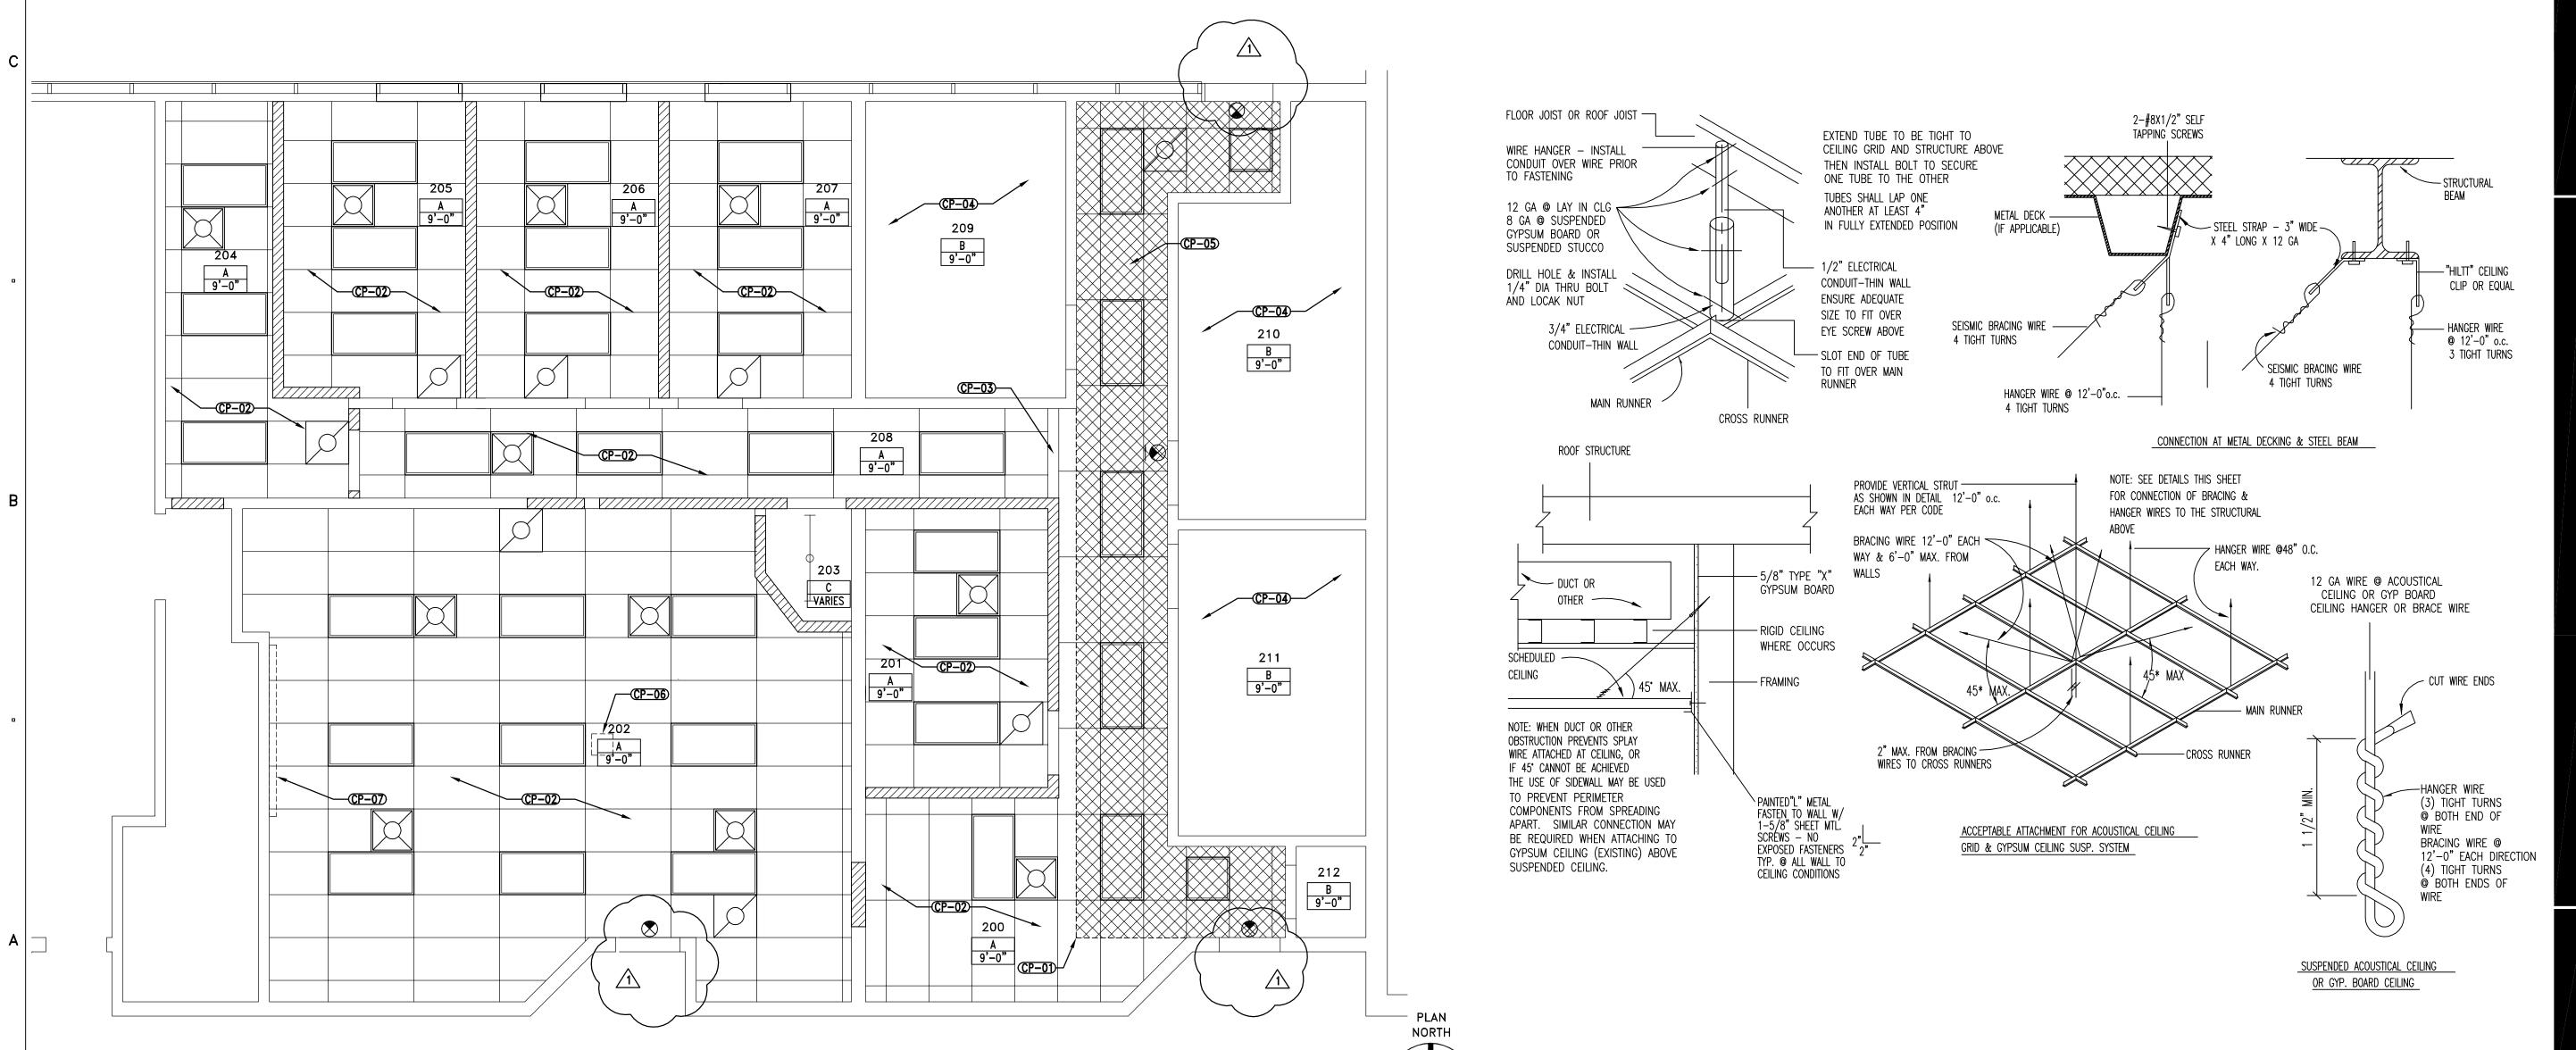

4' 3' 2' 1' 0' 2' 4'

A1 REFLECTED CEILING PLAN

SCALE: 1/4" = 1'-0"

AE121 REF.

STANISLAW 95-310818-0301 ISSUE 1 02-15-07 ADDENDUM #1 MARK DATE DESCRIPTION 077004 DFCM CONTRACT NO:


RALPH M.

DFCM PROJECT NO: 06126730 ARCHIPLEX PROJECT NO: 0620.01 E. RUSTEN DRAWN BY: R. STANISLAW CHECKED BY: AS SHOWN SCALE: DATE: OCTOBER 27, 2006 KEY PLAN

SHEET TITLE

REFLECTED CEILING PLAN AND DETAILS

AE121

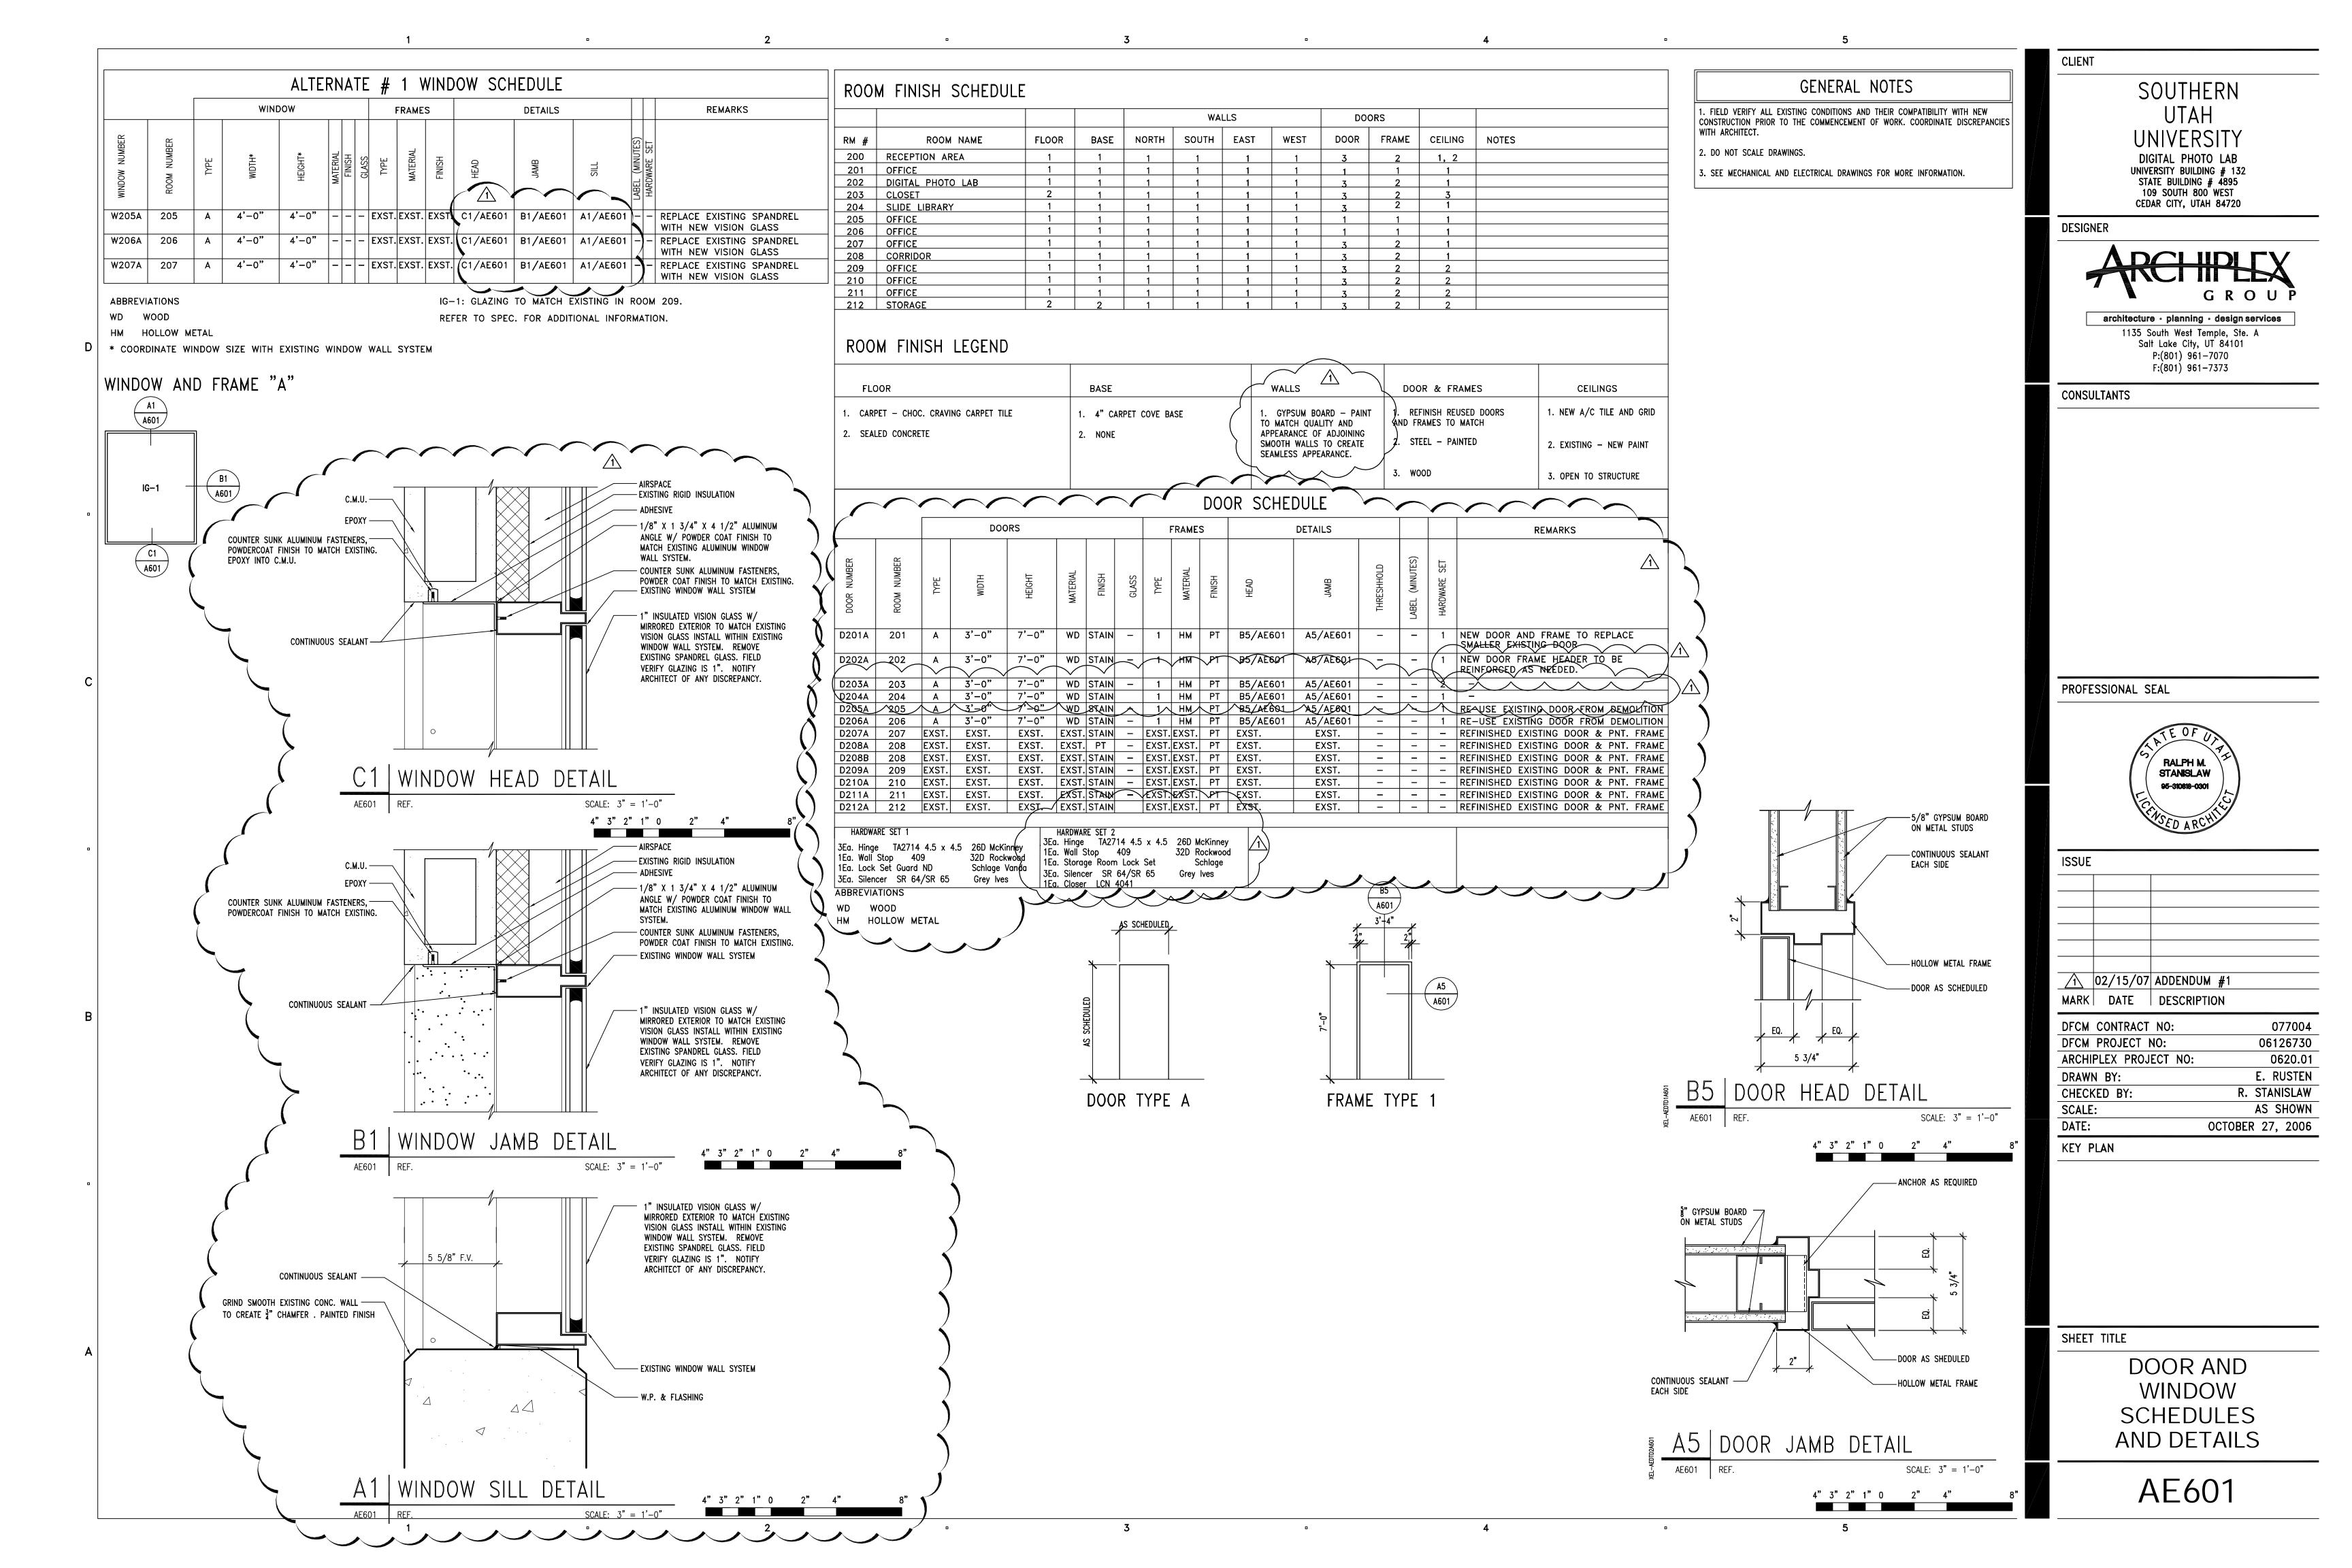

# SHEET KEYNOTES

- 1) PROVIDE 1" CONDUIT FORM SURFACE RACEWAY TO VOICE/DATA BOARD IN CLOSET 103. PROVIDE TWO COMPARTMENT SURFACE MOUNTED RACEWAY EQUAL TO WIREMOLD G5400 SERIES. PROVIDE POWER AND DATA OUTLETS AS INDICATED. REFER TO ARCHITECTURAL CABINET SECTIONS AND ELEVATIONS FOR MOUNTING HEIGHTS AND EXACT LOCATIONS.
- 3 NEW LOCATION OF RELOCATED VOICE/DATA BOARD, AND FOURPLEX RECEPTACLE. PROVIDE CEILING JUNCTION BOX AND EXTEND 2 #12 THHN CU. & 1 #12 GND. AS REQUIRED
- AND CONNECT TO STARE CIRCUIT IN PANEL 'LG1'. FINAL ELECTRICAL CONNECTION TO VIDEO PROJECTION BY OTHERS.
- TEACHER CONTROL STATION. PROVIDE JUNCTION BOX WITH (1) 1" CONDUIT TO CEILING PROJECTOR LOCATION AND (1) 1" CONDUIT TO CEILING PROJECTOR SCREEN LOCATION. PROJECTOR CONTROL STATION, SCREEN AND CONTROL WIRING PROVIDED BY OWNER. PROVIDE CEILING JUNCTION BOX AND EXTEND 2 #12 THHN CU. & 1 #12 GND. AS REQUIRED AND CONNECT TO SPARE CIRCUIT IN PANEL 'LG1'. FINAL ELECTRICAL CONNECTION TO PROJECTOR SCREEN BY DIVISION 16.
- PROVIDE NEW TYPED PANEL DIRECTORY CARD REFLECTING ALL CHANGES MADE TO CIRCUITING UNDER THIS REMODEL.
- PROVIDE 8" ROUND 70 WATT (8 OHM) CEILING MOUNTED SPEAKER EQUAL TO ATLAS FAP82T. EXTEND 14 GA. SPEAKER WIRE TO VOLUME CONTROL JUNCTION BOX TEACHERS DESK. VOLUME CONTROL AND ADDITIONAL AUDIO EQUIPMENT PROVIDED AND INSTALLED BY OTHERS.
- PROVIDE ADDRESSABLE FIRE ALARM DEVICES COMPATIBLE WITH EXISTING SYSTEM. EXTEND CONDUIT AND WIRING AS REQUIRED AND CONNECT INTO NEAREST ADDRESSABLE FIRE ALARM

UTAH UNIVERSITY DIGITAL PHOTO LAB UNIVERSITY BUILDING #132 STATE BUILDING #4895 109 SOUTH 800 WEST

DESIGNER




CEDAR CITY, UTAH 84720


architecture • planning • design services 1135 South West Temple, Ste. A Salt Lake City, UT 84101 P:(801) 961-7070

F:(801) 961-7373

CONSULTANTS

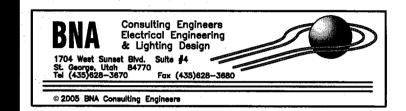

PROFESSIONAL SEAL

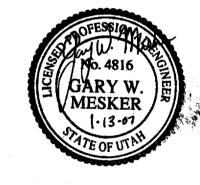


ISSUE		:	
1		h	
		. 1	
02/15		TH. MODU	
MARK DA		PTION	
DFCM CONT	RACT NO:		077005

DI ONI CONTRACT NO.	0//003
DFCM PROJECT NO:	06126730
BNA PROJECT NO:	06266SG.0
DRAWN BY:	
CHECKED BY:	
SCALE:	AS NOTED
DATE:	JANUARY 13, 2007
KEY PLAN	

SHEET TITLE

**NEW POWER** PLAN

EP102

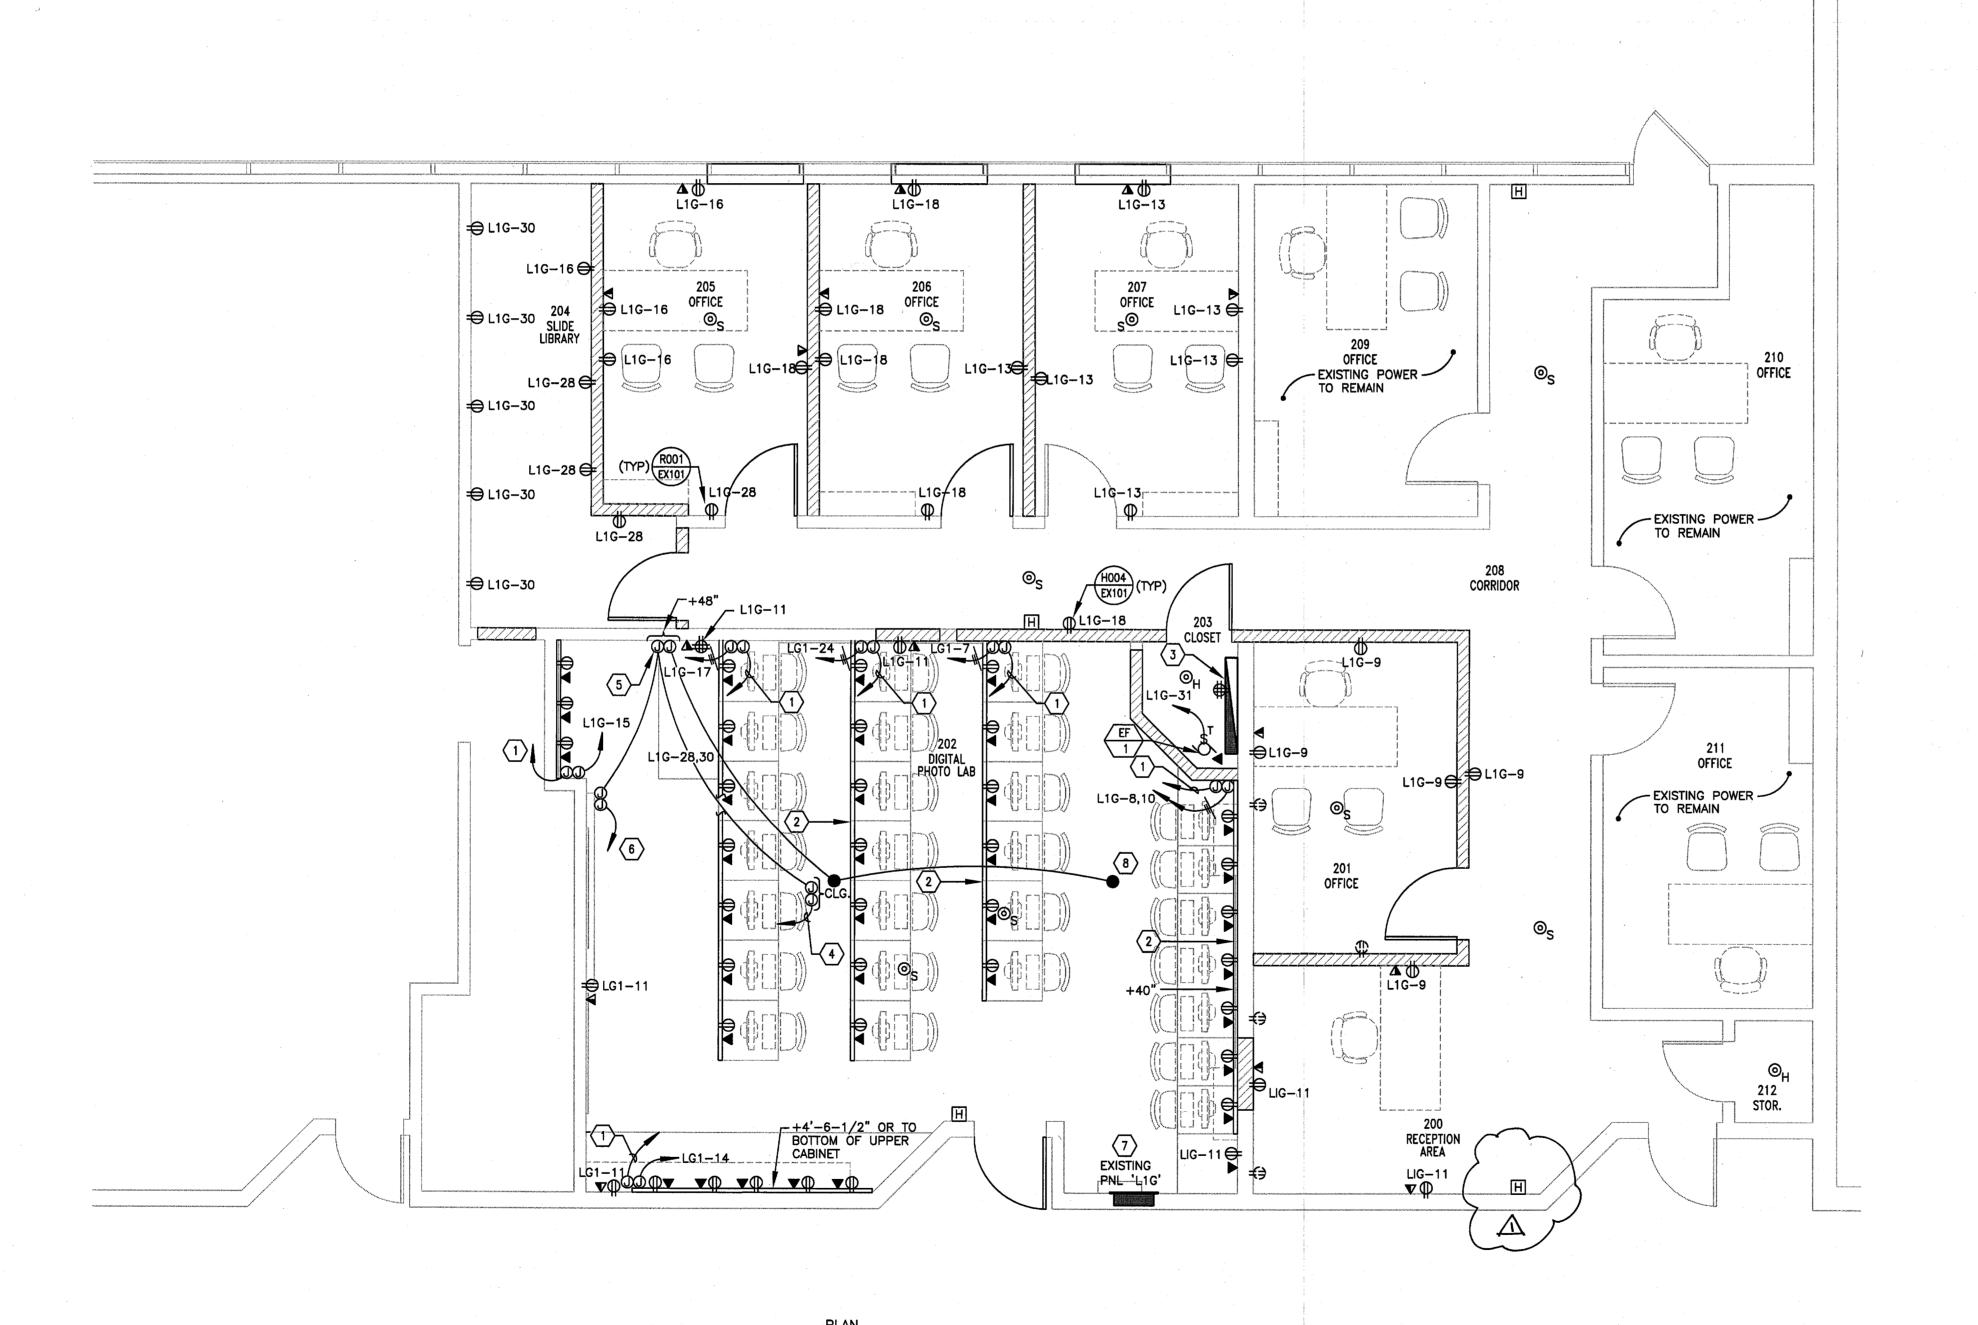

NEW POWER PLAN